# PENNSYLVANIA GAME COMMISSION

# PROJECT NO. PGC-289-22-01 STATE GAME LANDS #289


## NEW 40' x 80' CREW HEADQUARTERS BUILDING

WEST BURLINGTON TOWNSHIP, BRADFORD COUNTY, PENNSYLVANIA


CONTRACT NO. 1: GENERAL CONSTRUCTION CONTRACT NO. 3: PLUMBING CONSTRUCTION CONTRACT NO. 4: ELECTRICAL CONSTRUCTION

#### SITE PLAN GENERAL NOTES:

- I. UTILITY LINE LOCATIONS SHOWN ON THE DRAWINGS ARE APPROXIMATE. UNDERGROUND TELEPHONE, ELECTRIC, GAS, SANITARY SEWER, WATER AND STORMWATER DRAINAGE LINES MAY BE PRESENT AT SOME WORK LOCATIONS. FIELD VERIFICATION IS REQUIRED PRIOR TO ANY CONSTRUCTION. CONTACT PA ONE CALL AND COMPLY WITH ACT 287 (AS AMENDED) REGARDING LOCATIONS OF UNDERGROUND UTILITIES.
- 2. ALL WORK WITHIN THE PUBLIC RIGHT-OF-WAY SHALL BE CONDUCTED IN ACCORDANCE WITH THE REQUIREMENTS OF PENNDOT, THE LOCAL MUNICIPALITY AND THE CONTRACT DOCUMENTS.
- 3. CONTRACTOR SHALL COORDINATE WITH AFFECTED UTILITY COMPANIES IN THE EVENT ITEMS SUCH AS TEMPORARY POLE SUPPORT IS REQUIRED. THIS WORK SHALL BE COMPLETED AT NO ADDITIONAL COST TO THE OWNER.
- 4. EXISTING DRAINAGE FACILITIES SHALL REMAIN INTACT DURING CONSTRUCTION, UNLESS OTHERWISE DIRECTED BY THE ENGINEER.
- 5. ALL AREAS DISTURBED BY THE CONSTRUCTION WORK SHALL BE RESTORED IN ACCORDANCE WITH THE CONTRACT DOCUMENTS TO THEIR ORIGINAL CONDITION OR BETTER.
- 6. ALL DISTURBED AREAS NOT RECEIVING OTHER SURFACE TREATMENT SHALL BE GRADED, SEEDED, AND MULCHED.
- 7. CONTRACTOR SHALL REFER TO CONTRACT DOCUMENTS FOR SOIL EROSION \$ SEDIMENTATION CONTROL PLAN REQUIREMENTS.
- 8. MAINTAIN ACCESS TO DRIVEWAYS AND ENTRANCES LOCATED ALONG THE PROJECT.
- 9. THE CONTRACTOR SHALL ENSURE THAT ALL CONSTRUCTION VEHICLES (INCLUDING MATERIAL SUPPLIER VEHICLES) LEAVING THE PROJECT AREA HAVE MUD BUILDUP REMOVED FROM THE TIRES BEFORE EXITING ONTO PAVED ROADWAYS. ALL MUD TRACKED ONTO PAVED ROADWAYS SHALL BE IMMEDIATELY REMOVED FROM THE ROADWAY.

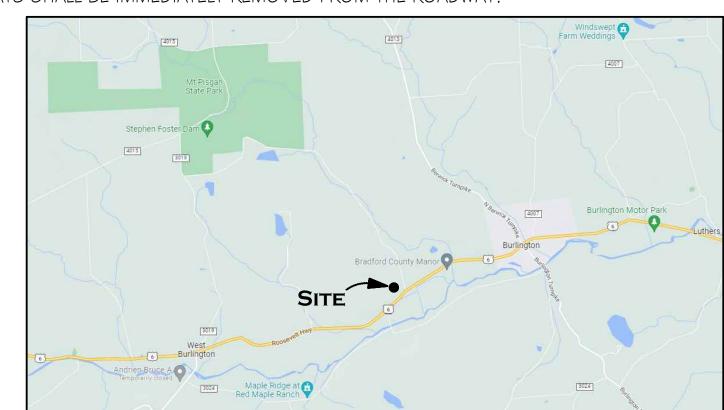



PROJECT VICINITY MAP

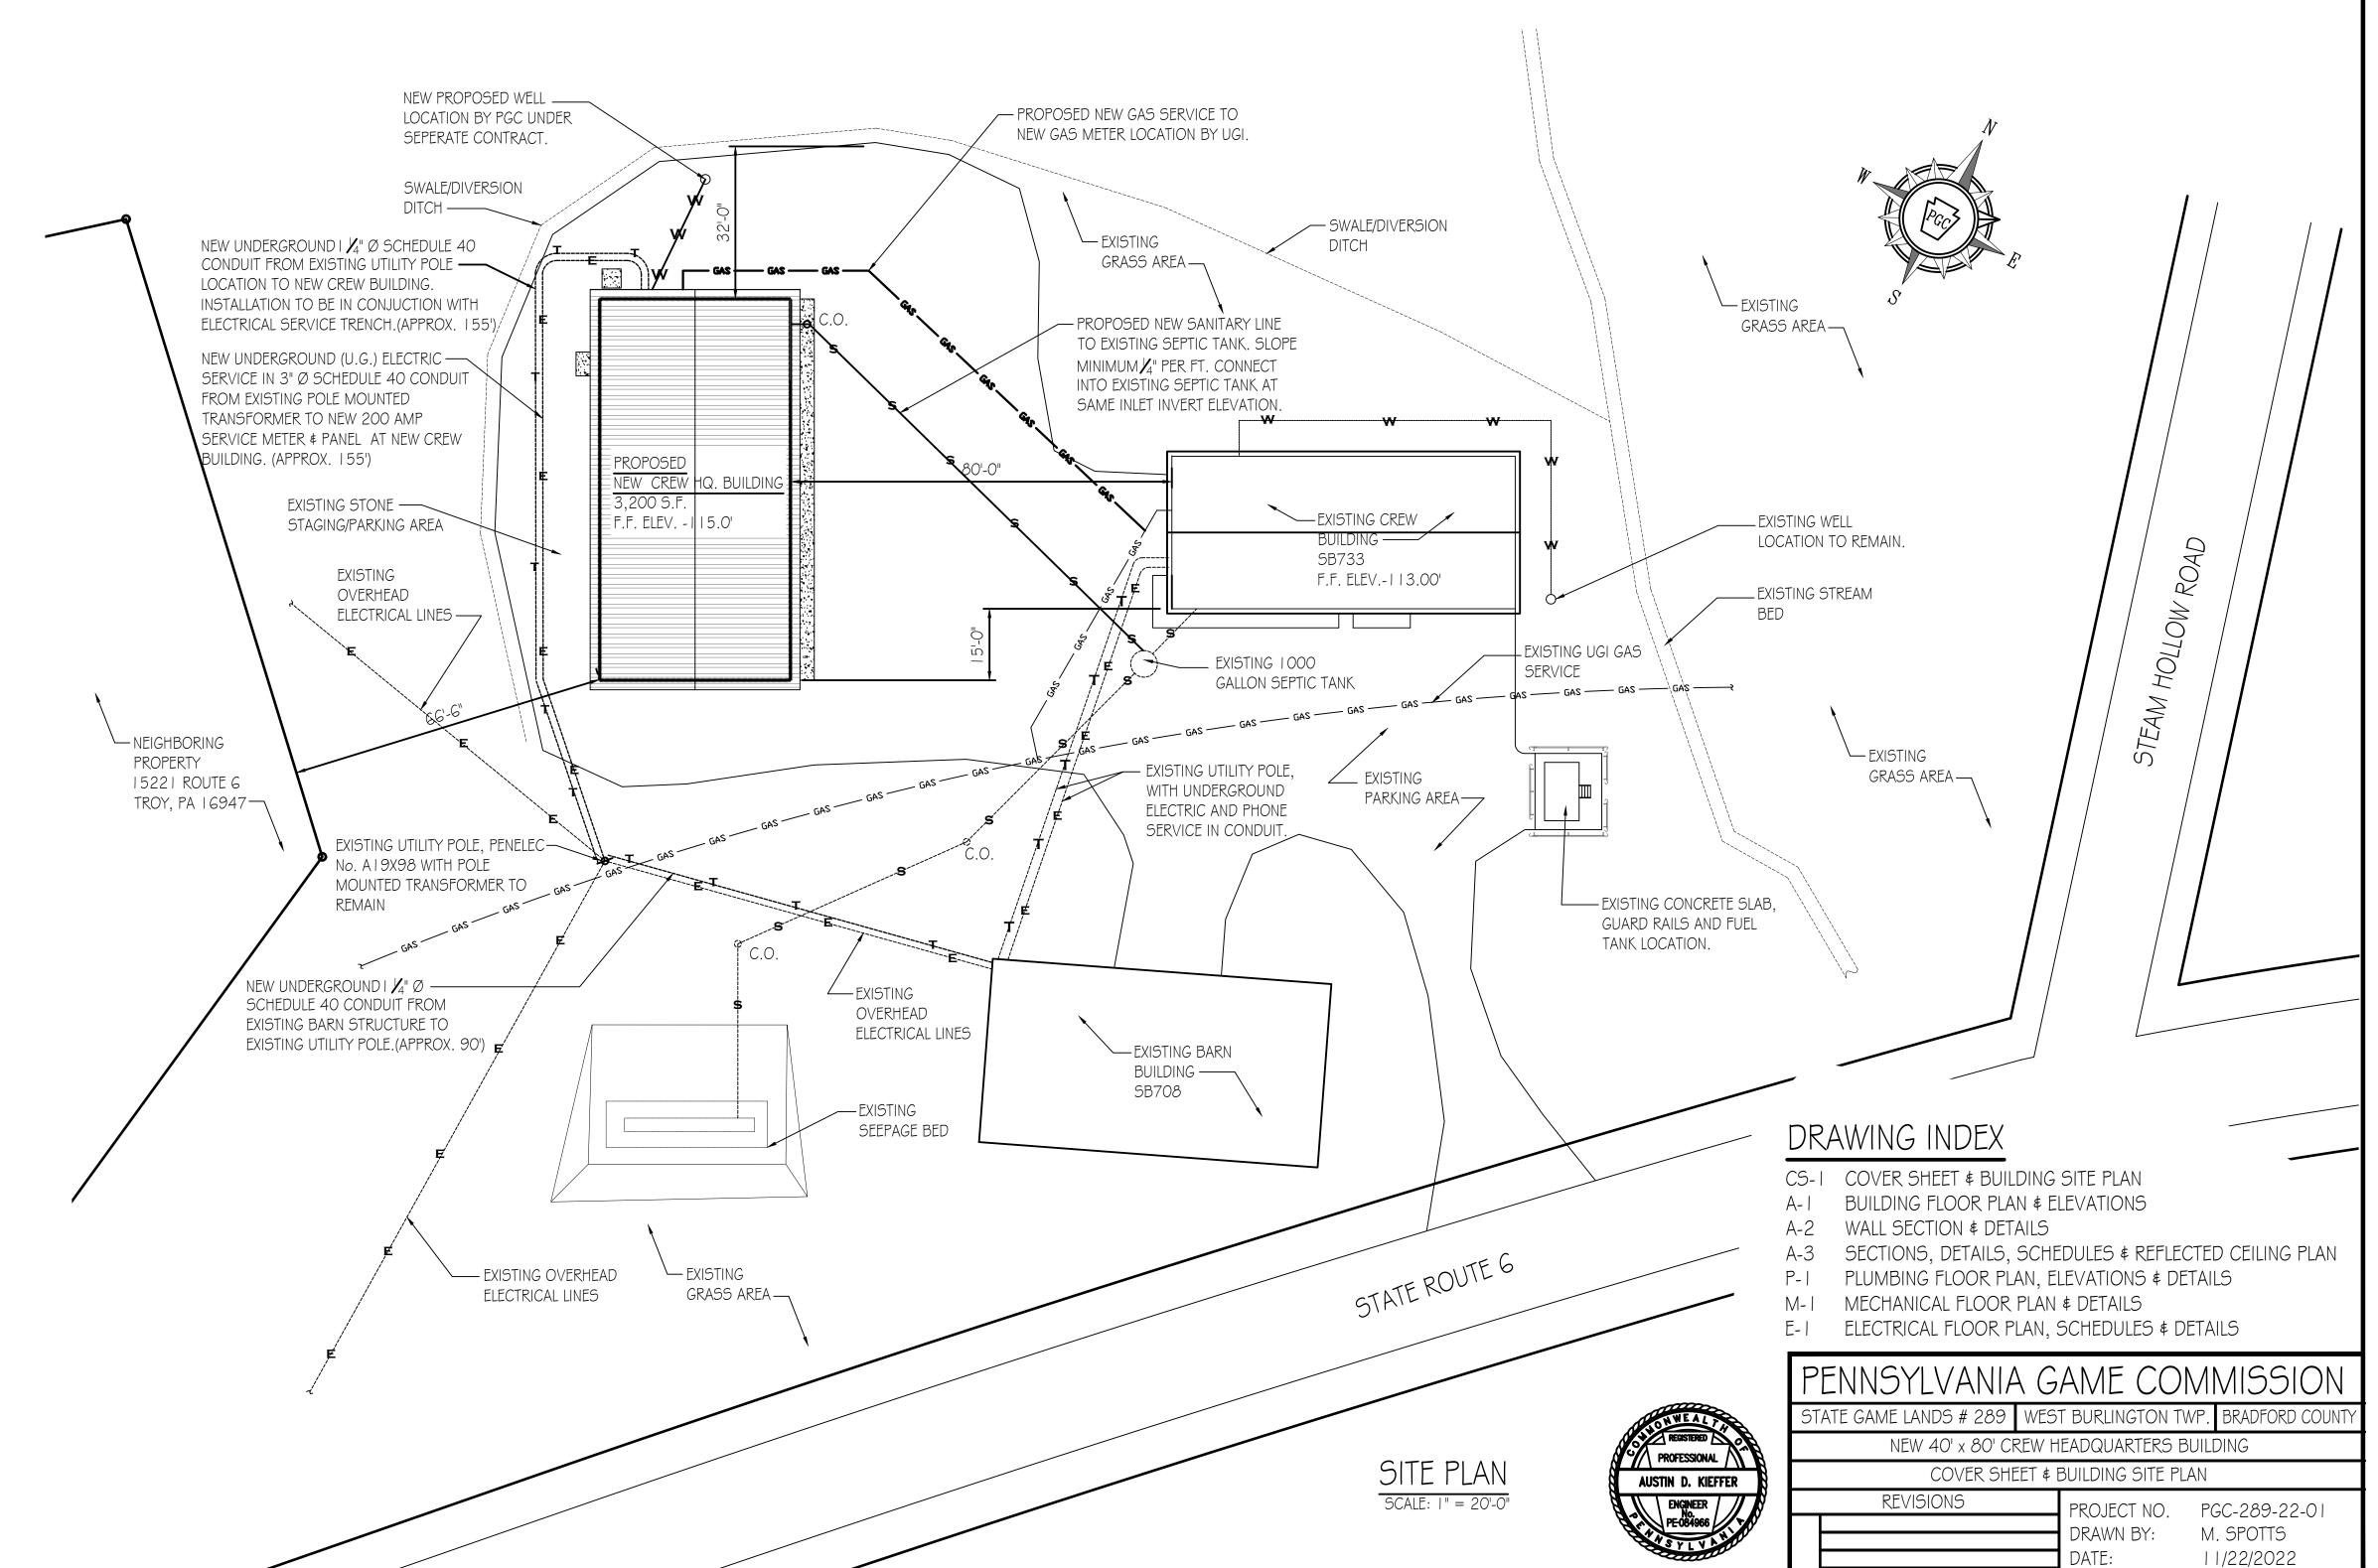


SHEET NO.

CS-I

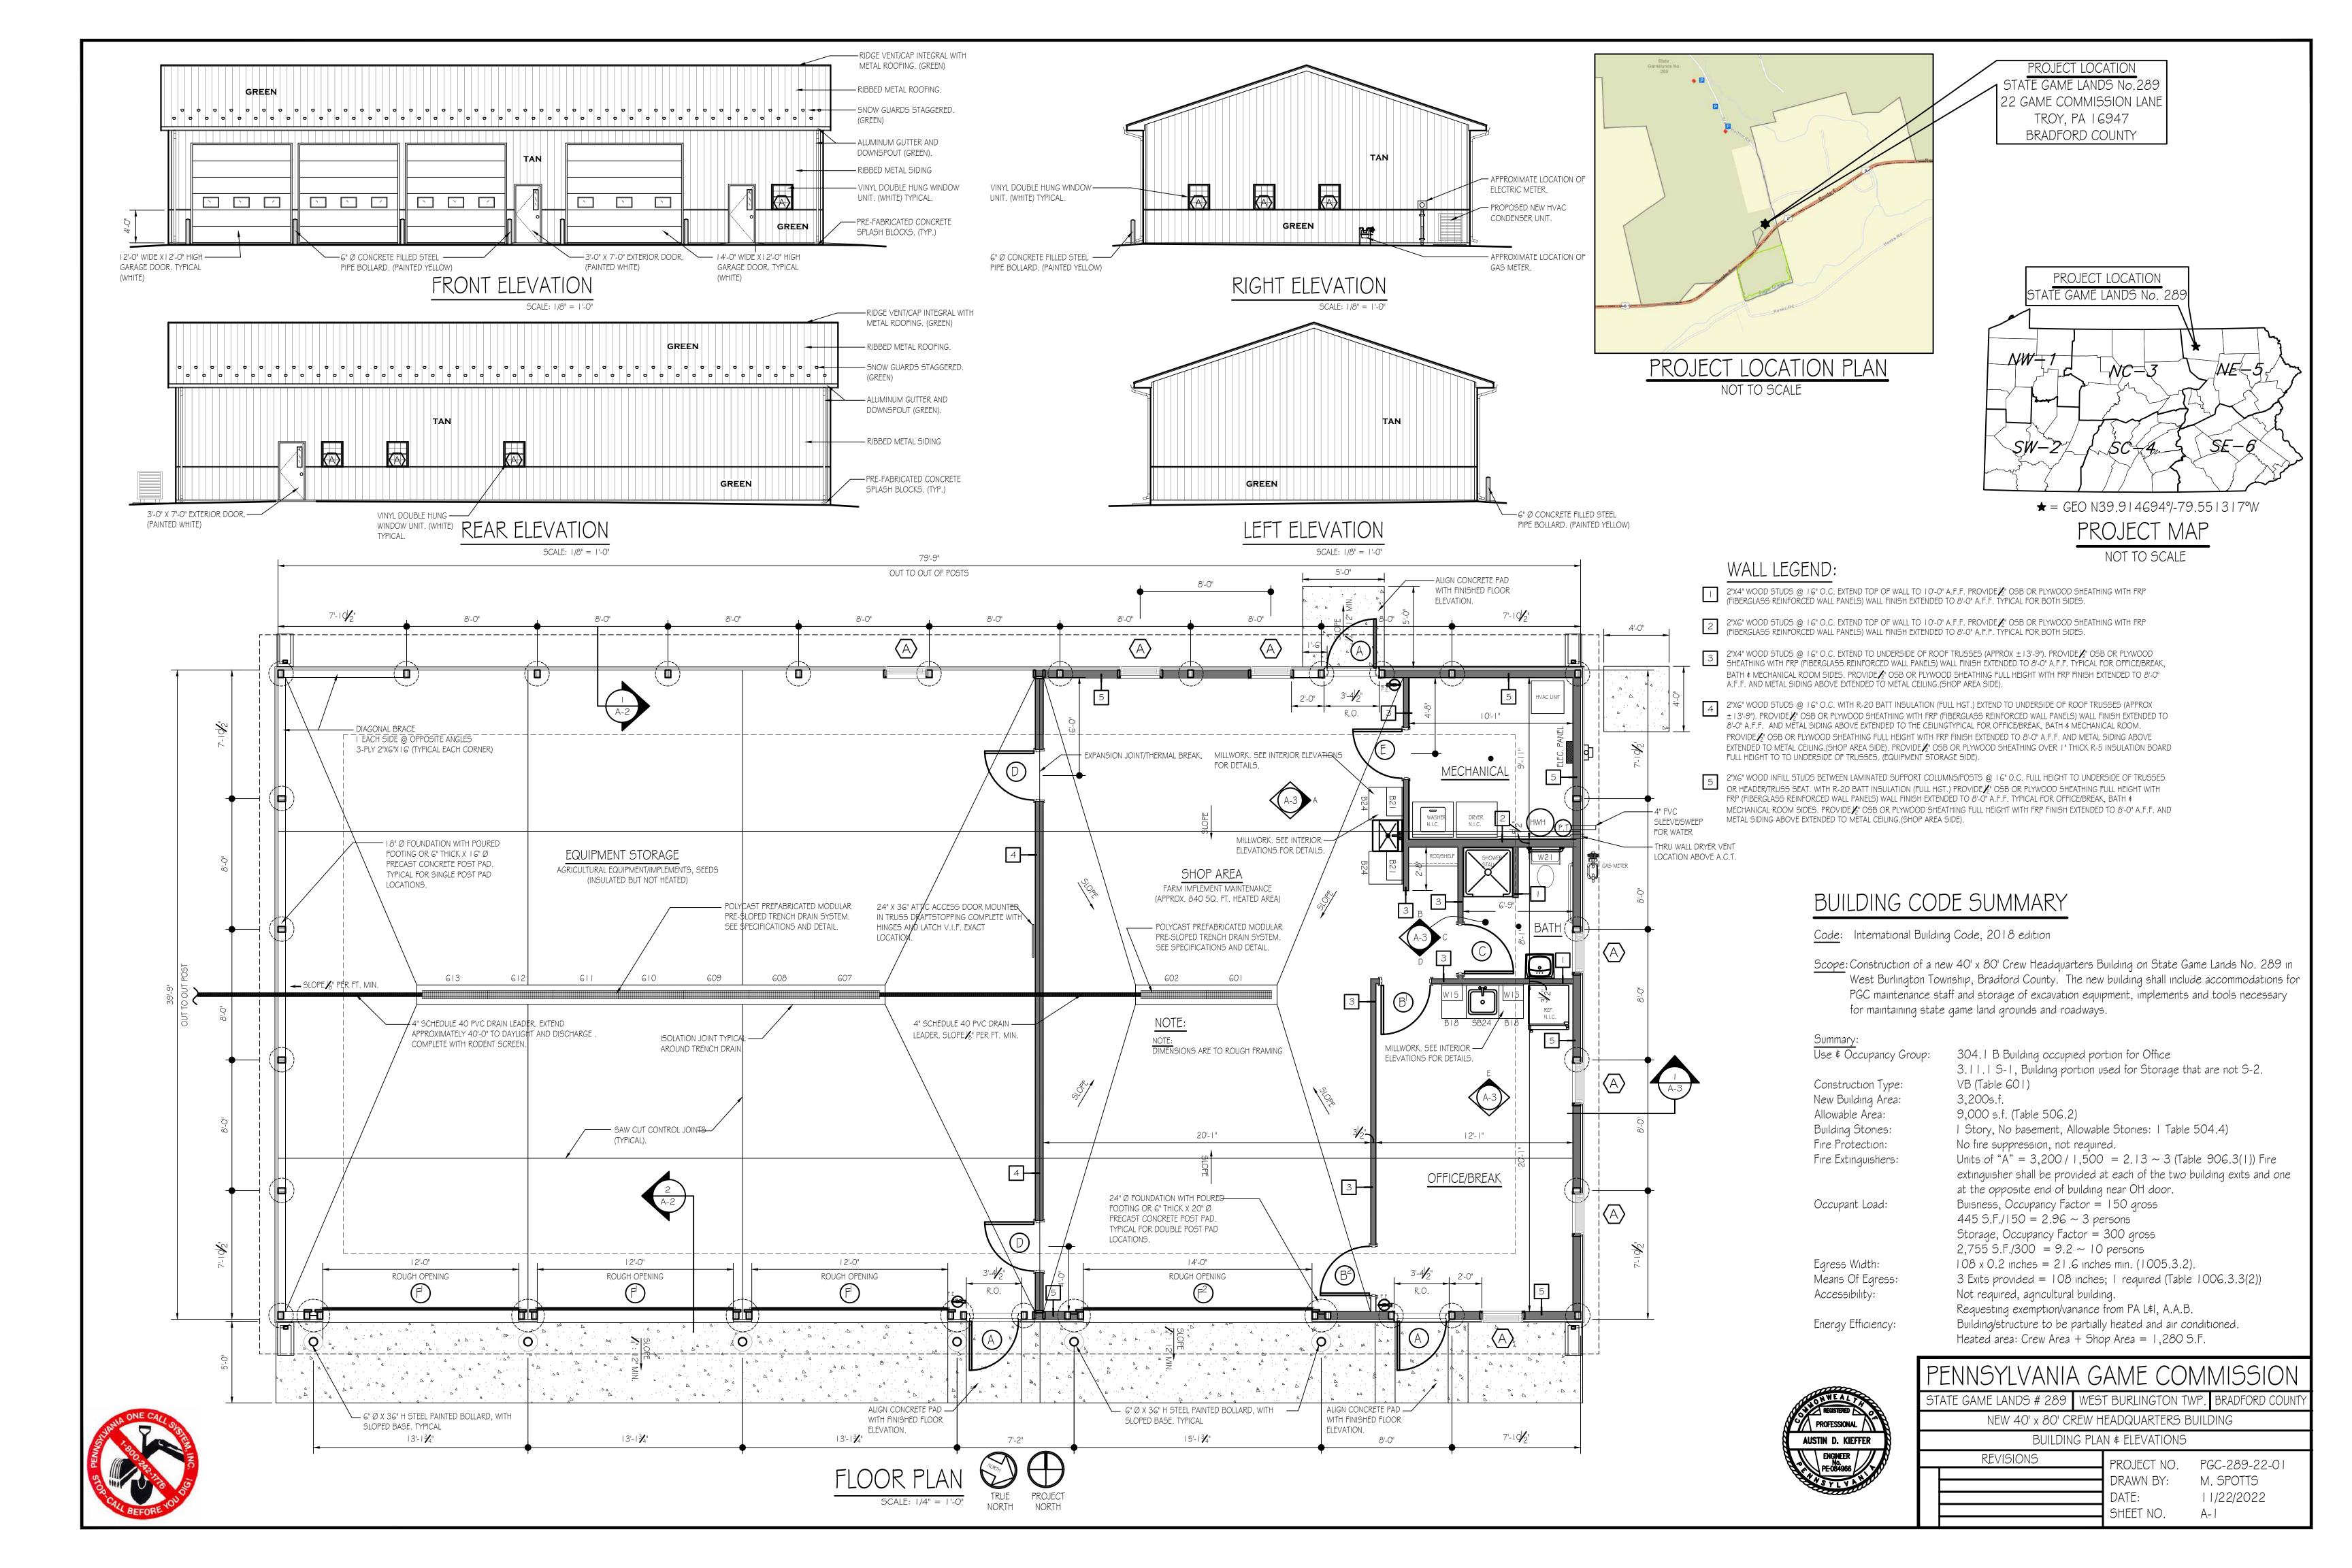

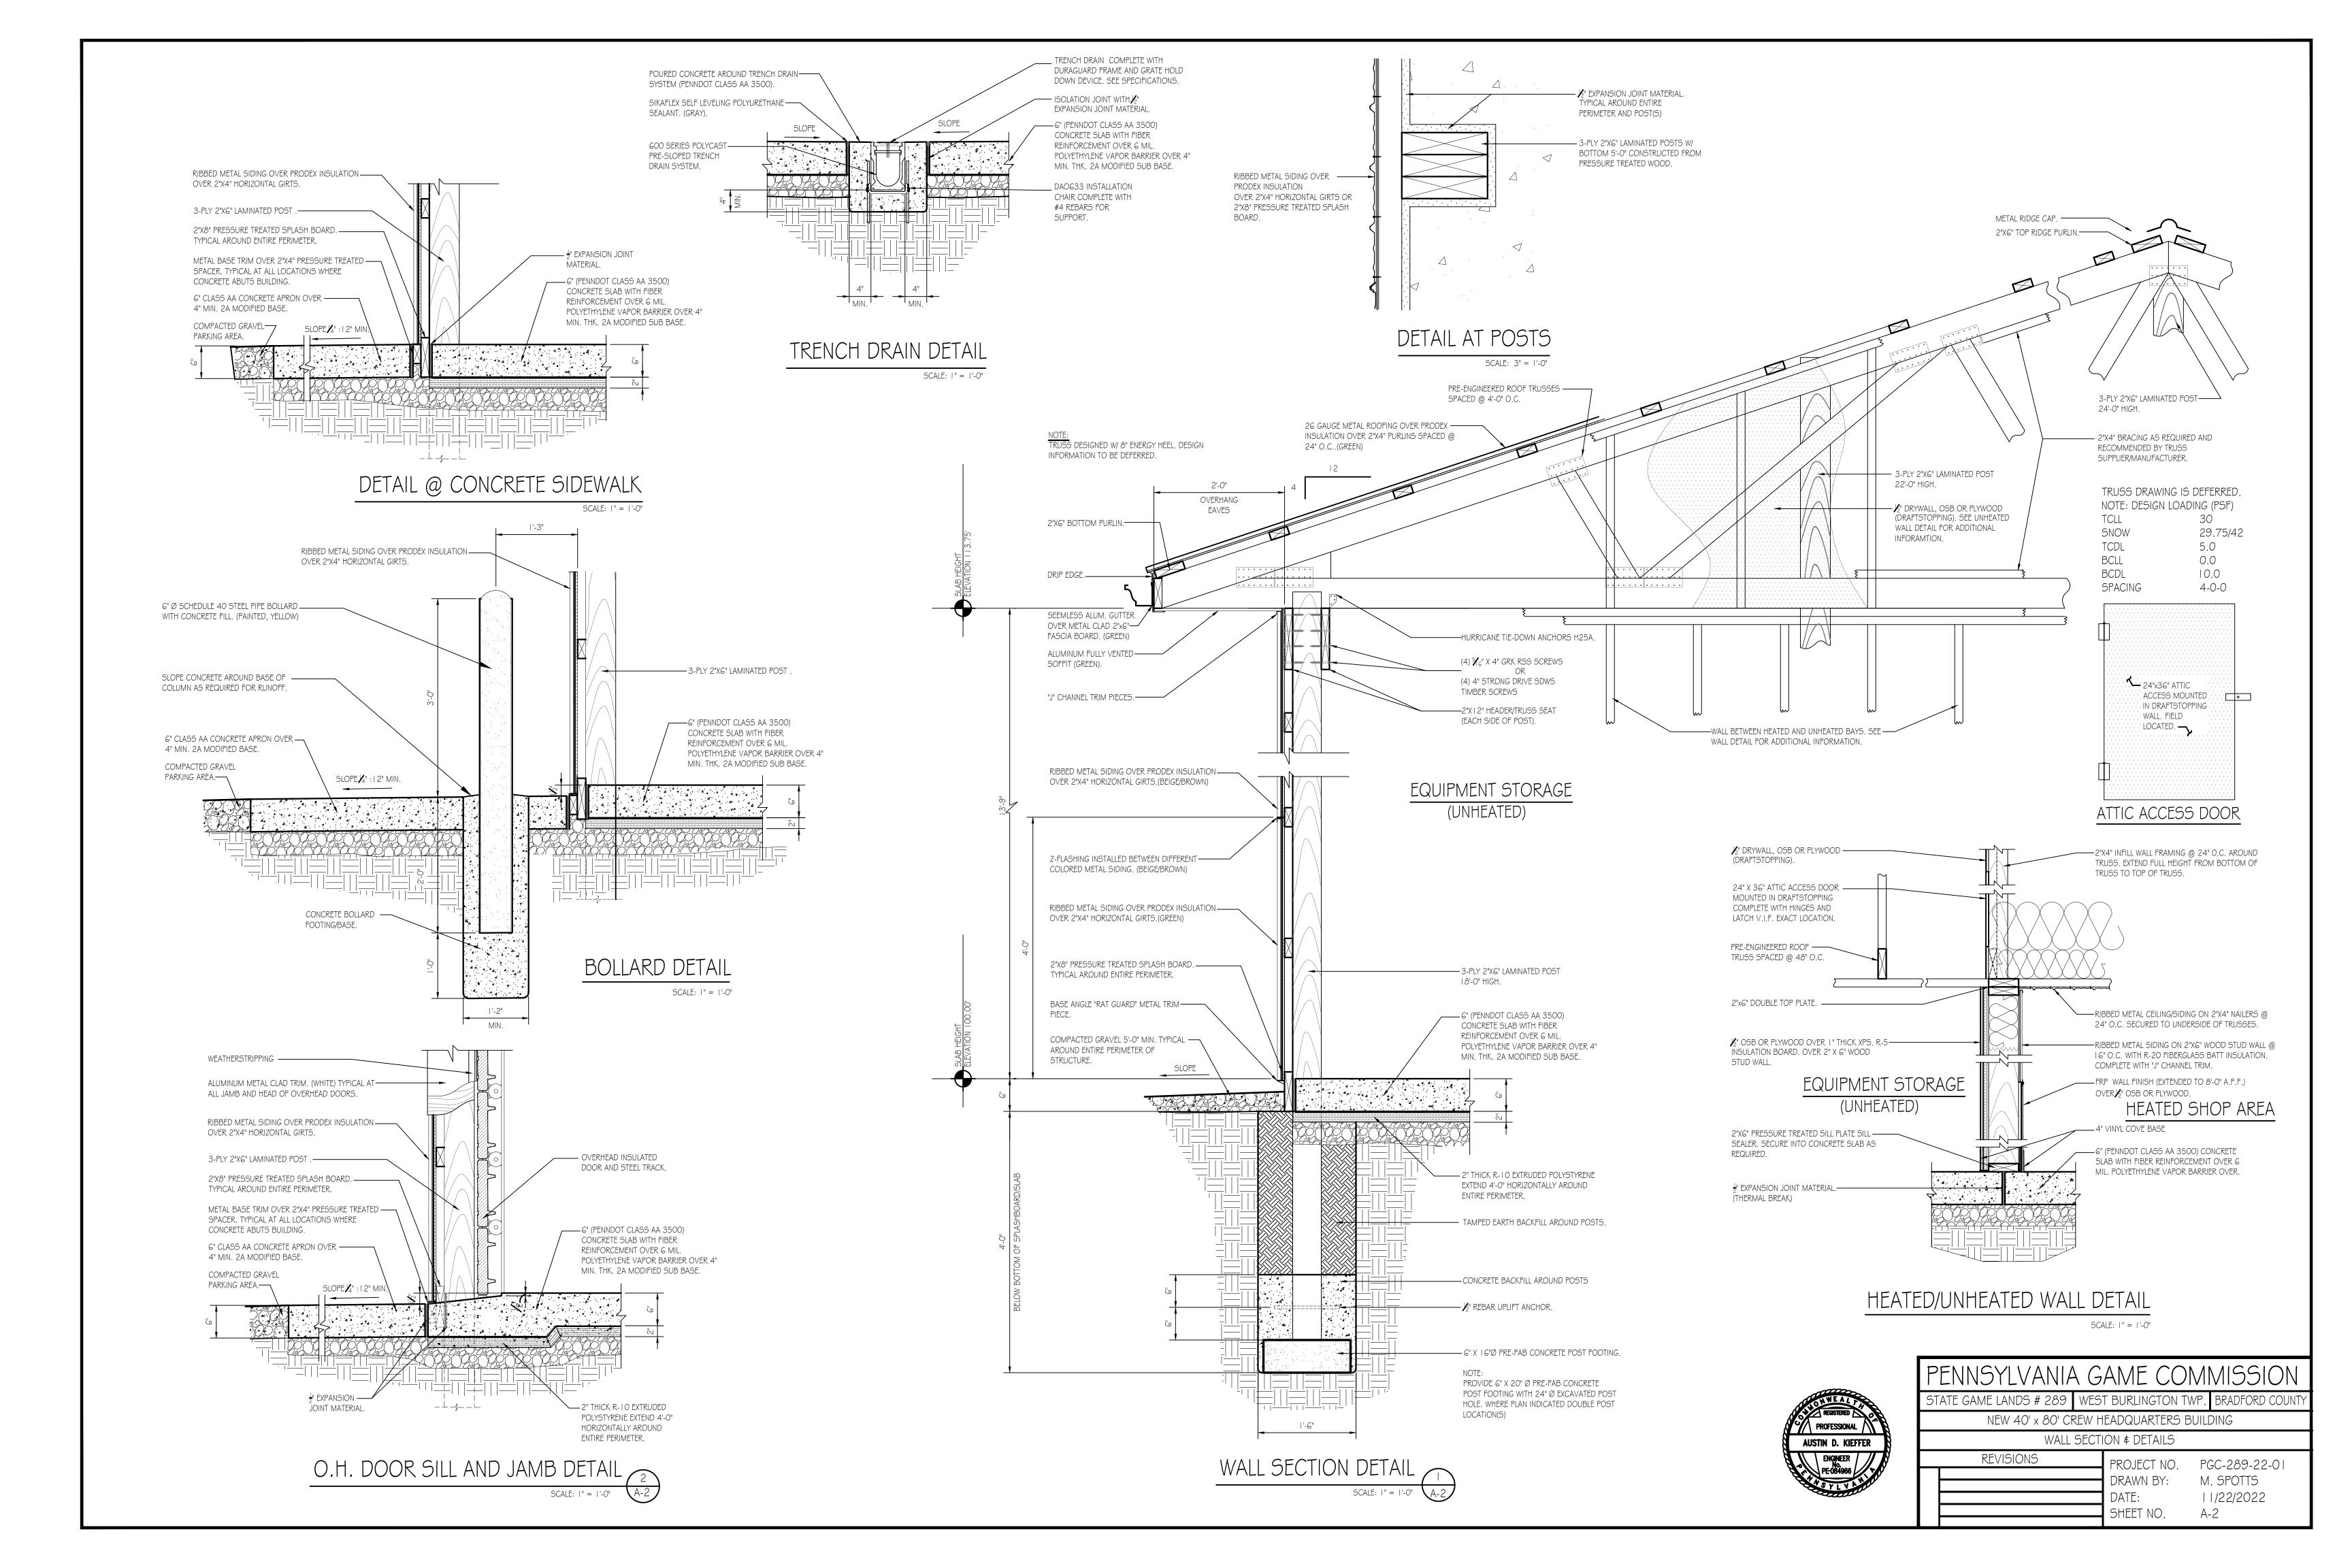

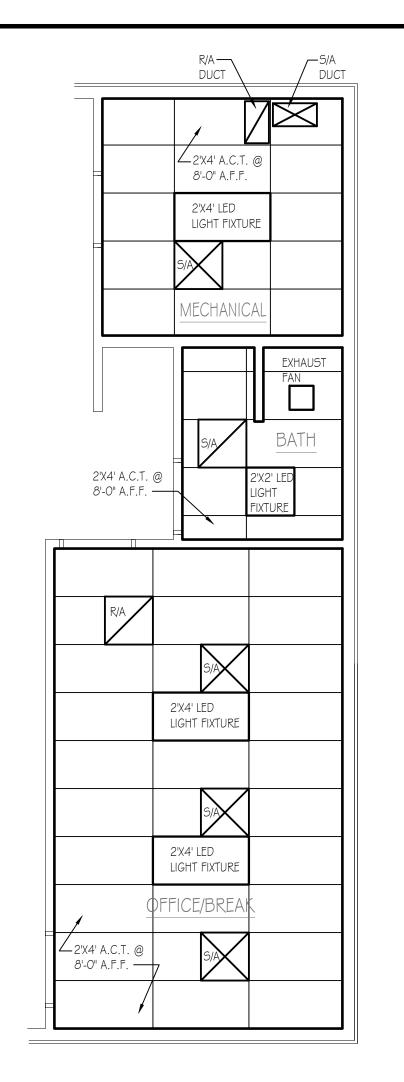


## REFLECTED CEILING PLAN

MARK TYPE MANUFACTURER ROUGH OPENING COLOR QTY. REMARKS


Α	I	VINYL	2'-6" x 3'-0"	WHITE	7	WINDOW UNIT IN BATH TO HAVE BOTTOM SASH TEMPERED GLASS		
				WIND	CHEDULE NOTES:			
				I)ALL WINDOWS TO BE COMPLETE WITH CLEAR LOW E GLASS W/ ARGON, INSECT SCREENS, GRILLES BETWEEN GLASS, INTEGRAL "J" CHANNEL TRIM AND TEMPERED GLASS AS REQUIRED BY CODE.				
				2)EXTERIOR AND INTERIOR WINDOW COLOR TO BE WHITE.				
	TYPE			3)SEE SPECIFICATIONS FOR ADDITIONAL WINDOW INFORMATION.				

## WINDOW SCHEDULE


$ \begin{array}{c ccccccccccccccccccccccccccccccccccc$	K TYPE	WIDTH	HGT.	THK.	HAND	QTY.	REMARKS	
B <sup>2</sup> I C 2 D I E 4 P O.H.	3	3'-0"	7'-0"	1-3/4"	LHR	3	INSULATED CORE W/ GLASS, PANIC EXIT DEVICE, CLOSER	
C 2 D 1 E 4 F O.H.		3'-0"	7'-0"	1-3/4"	RH	1	NON-INSULATED W/GLASS & PASSAGE SET	
D     E   4   F   O.H.		3'-0"	7'-0"	1-3/4"	RHR		NON-INSULATED W/GLASS & PASSAGE SET	
E 4 F O.H.	2	3'-0"	7'-0"	1-3/4"	RH		NON-INSULATED W/ PRIVACY SET	
f O.H.		3'-0"	7'-0"	1-3/4"	1-3/4" LHR 2		INSULATED CORE W/ GLASS, PANIC EXIT DEVICE, CLOSER	
0.11.	4	3'-0"	7'-0"	I-3/4"	LHR	1	NON-INSULATED W/GLASS, VENT \$ PASSAGE SET	
F <sup>2</sup> O.H.	О.Н.	12'-0"	12'-0"	SEE SPECIFI	SEE SPECIFICATIONS		INSULATED SECTIONAL OVERHEAD DOOR	
	О.Н.	14'-0"	12'-0"	SEE SPECIFI	SEE SPECIFICATIONS		INSULATED SECTIONAL OVERHEAD DOOR	

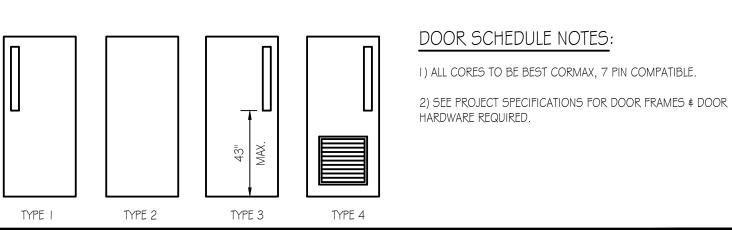


DOOR SCHEDULE

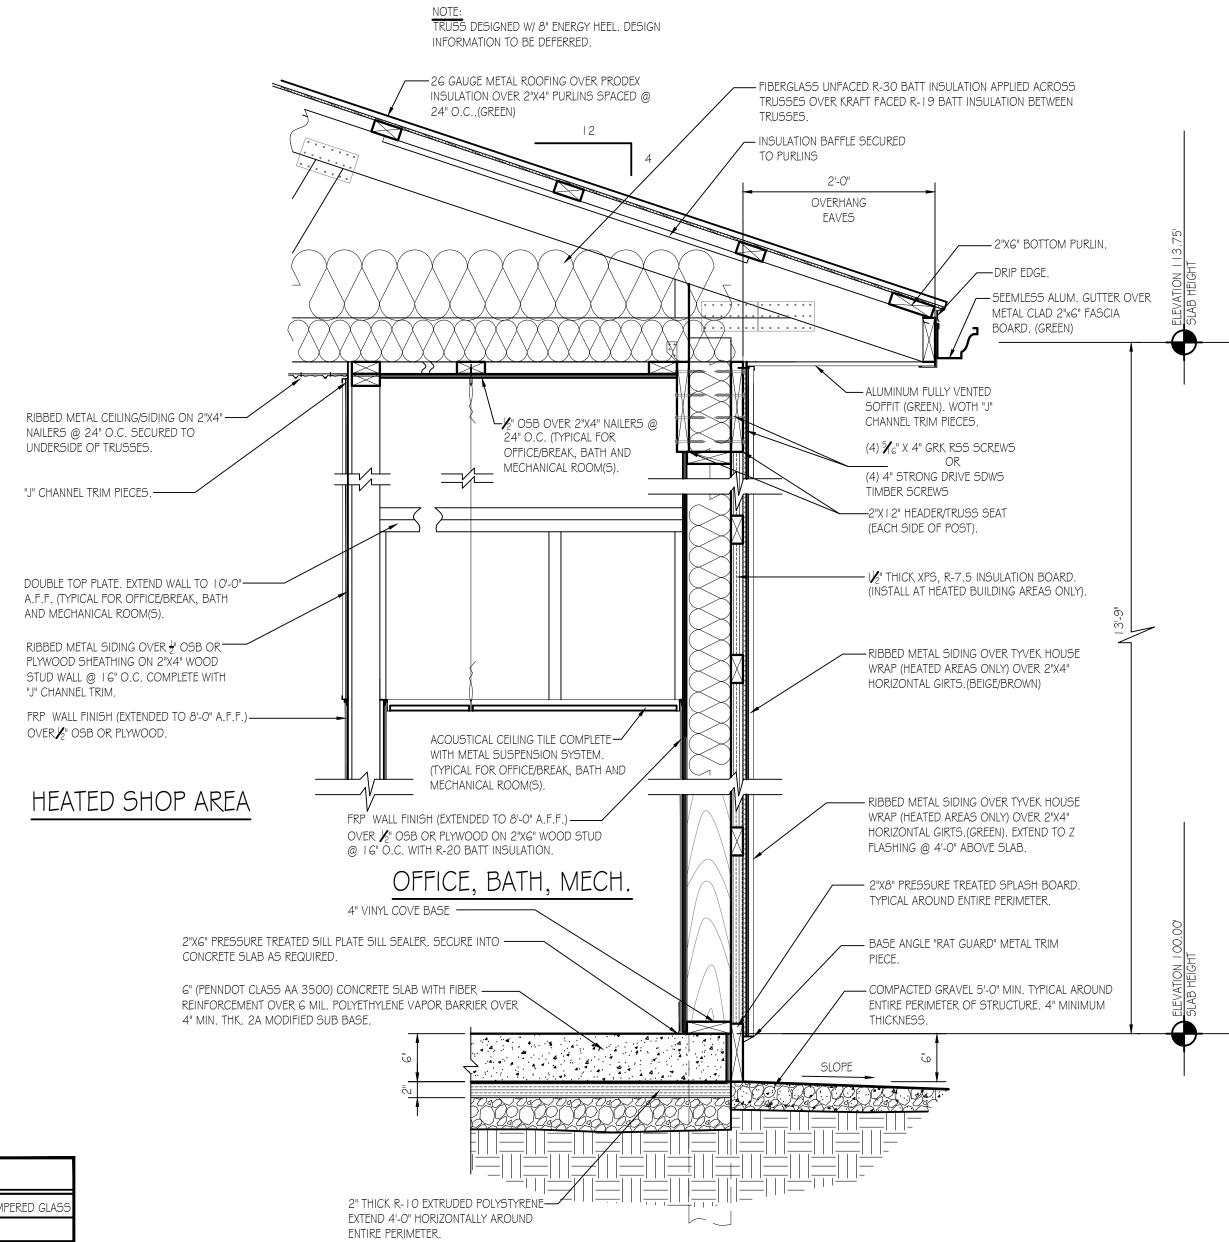



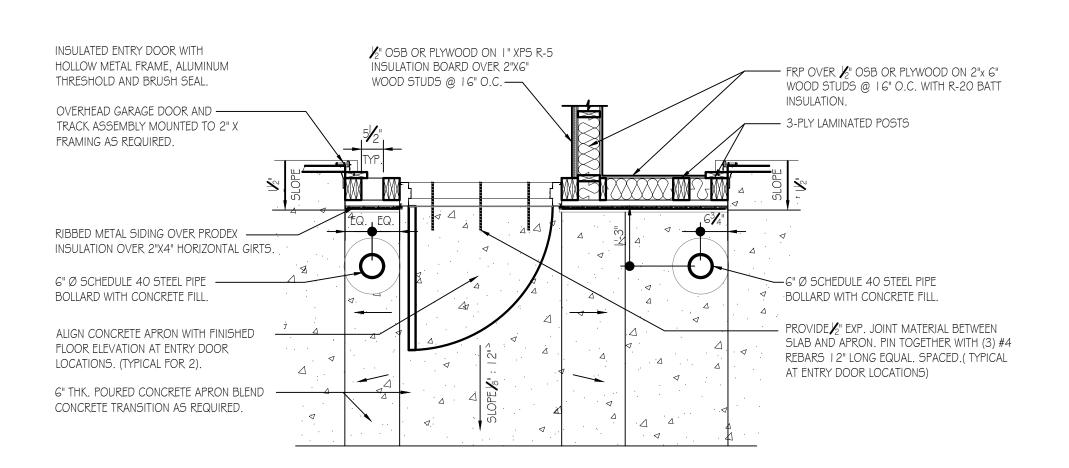


DETAIL AT ENTRY DOOR

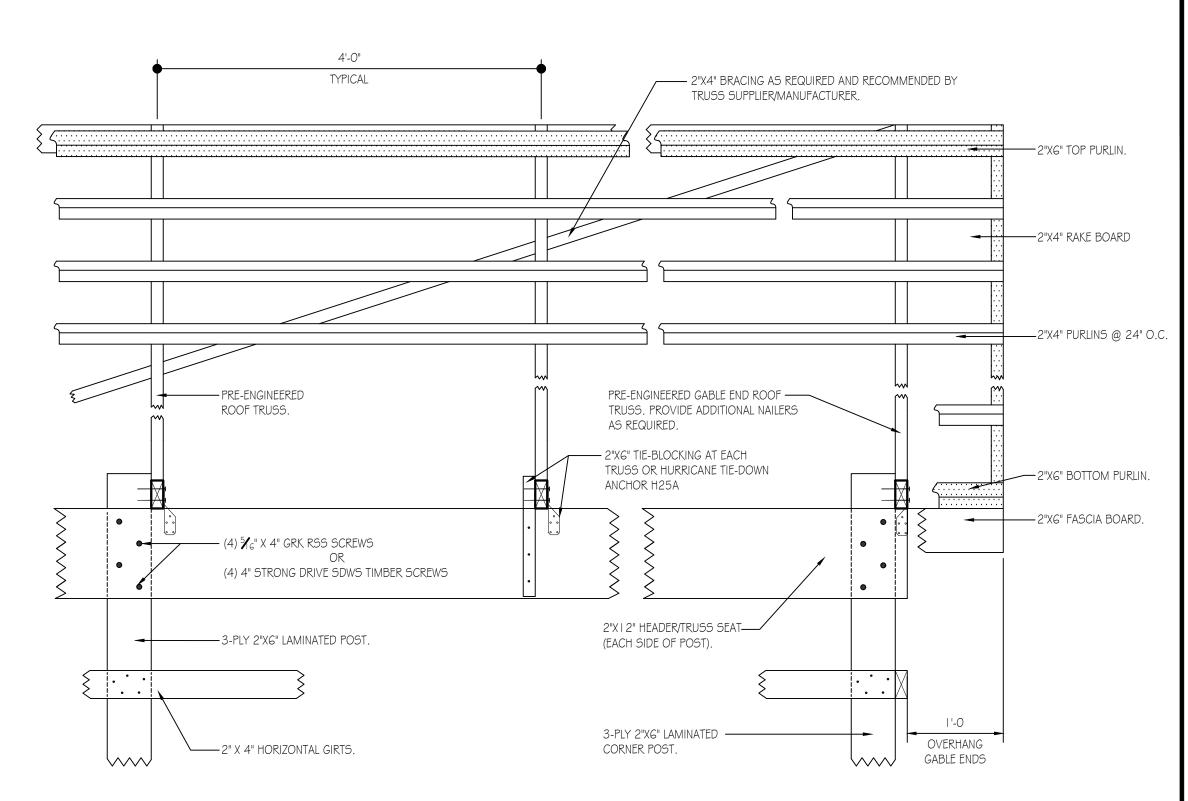


### TYPICAL ROOF FRAMING/BRACING DETAIL

SCALE: |" = |'-0"

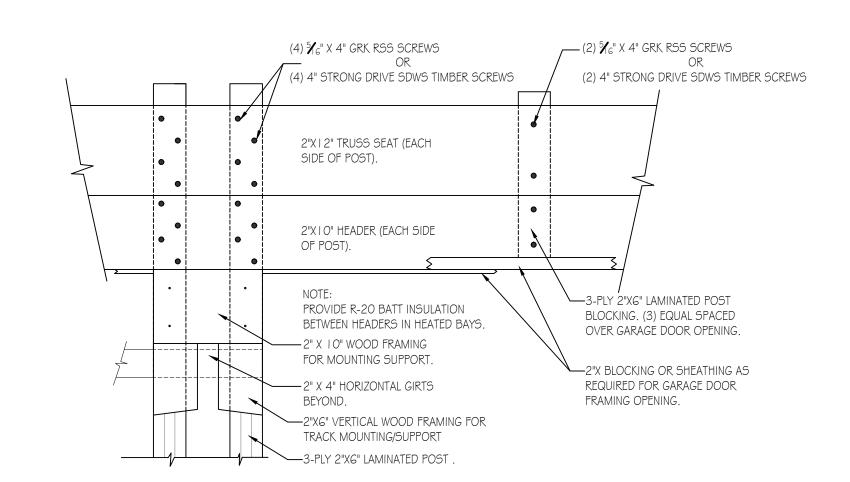

### GARAGE DOOR FRAMING DETAIL

SCALE: 1" - 1' O"

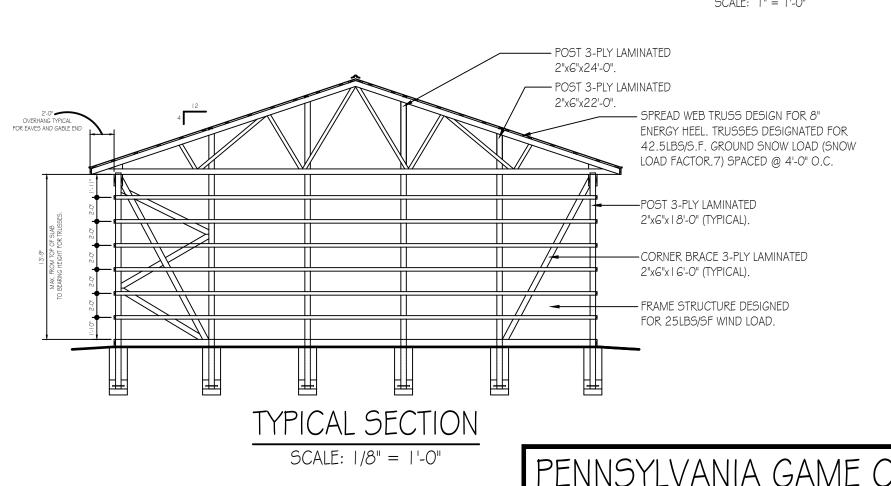

PENNSYLVANIA GAME COMMISSION STATE GAME LANDS # 289 WEST BURLINGTON TWP. BRADFORD COUNT

NEW 40' x 80' CREW HEADQUARTERS BUILDING
SECTIONS, DETAILS, SCHEDULES & REFLECTED CEILING PLAN

REVISIONS

PROJECT NO. PGC-289-22-01

DRAWN BY: M. SPOTTS


DATE: 11/22/2022


SHEET NO. A-3

PROFESSIONAL

AUSTIN D. KIEFFER

ENGINEER
PE-084966

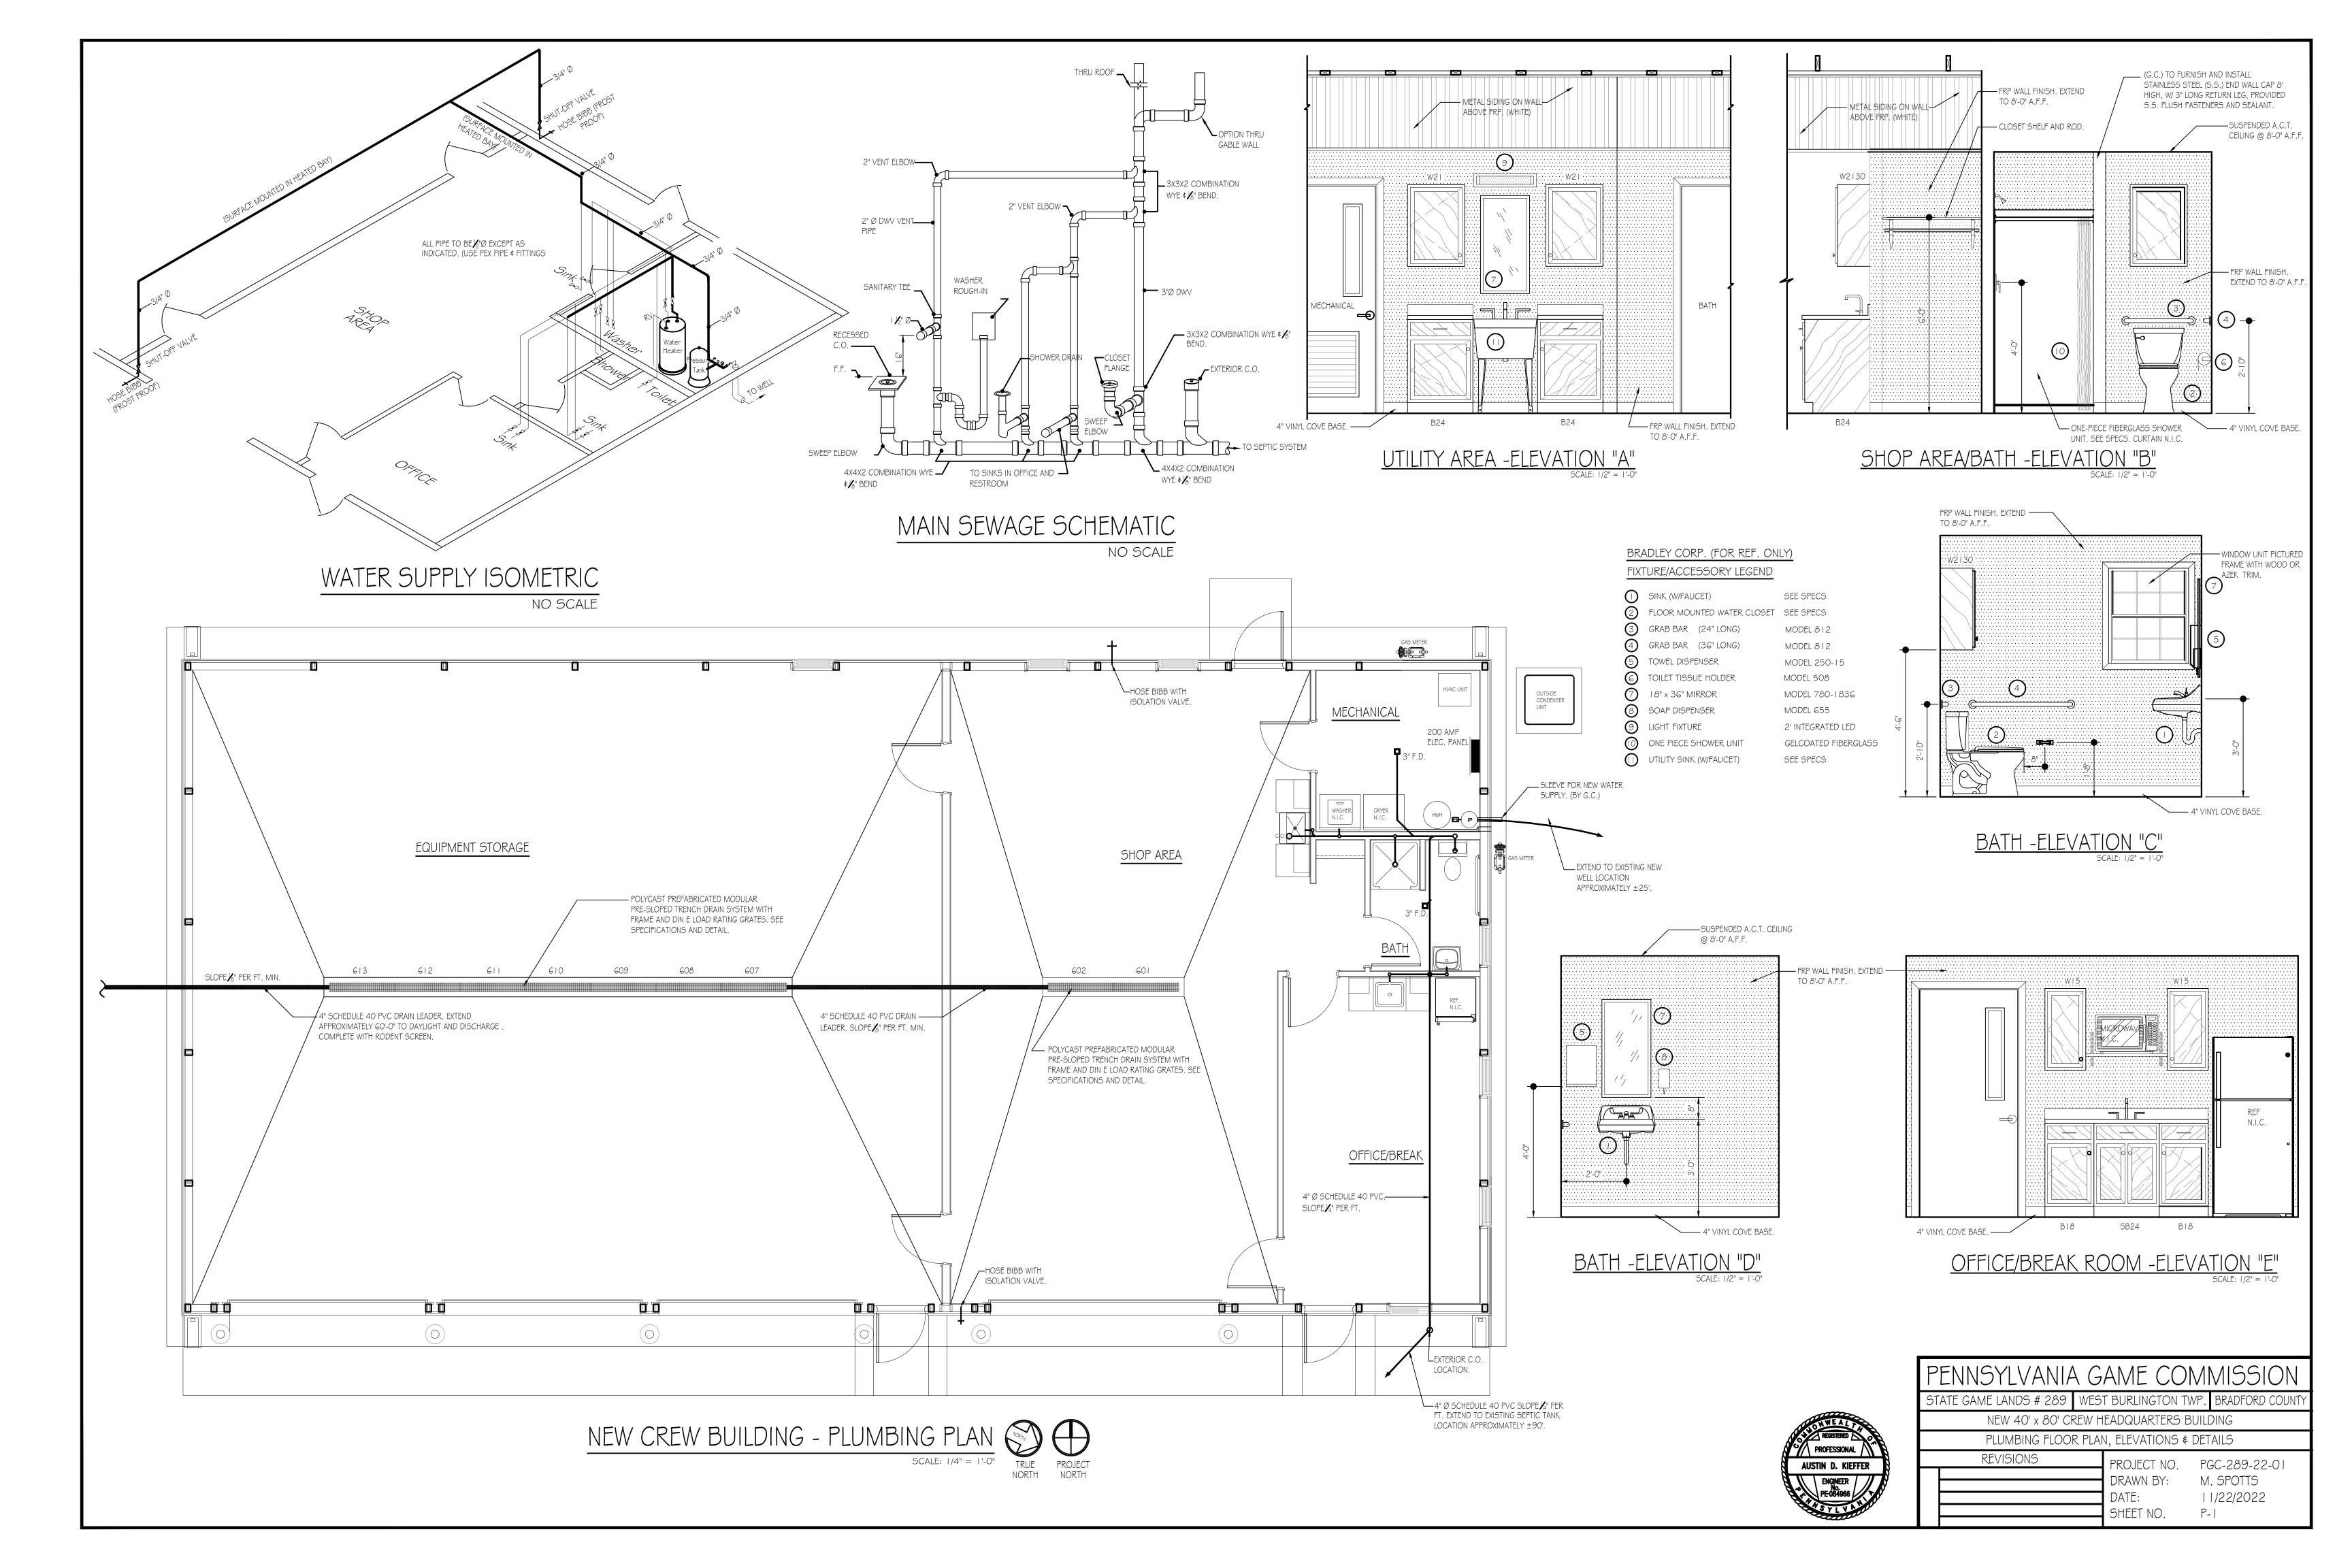

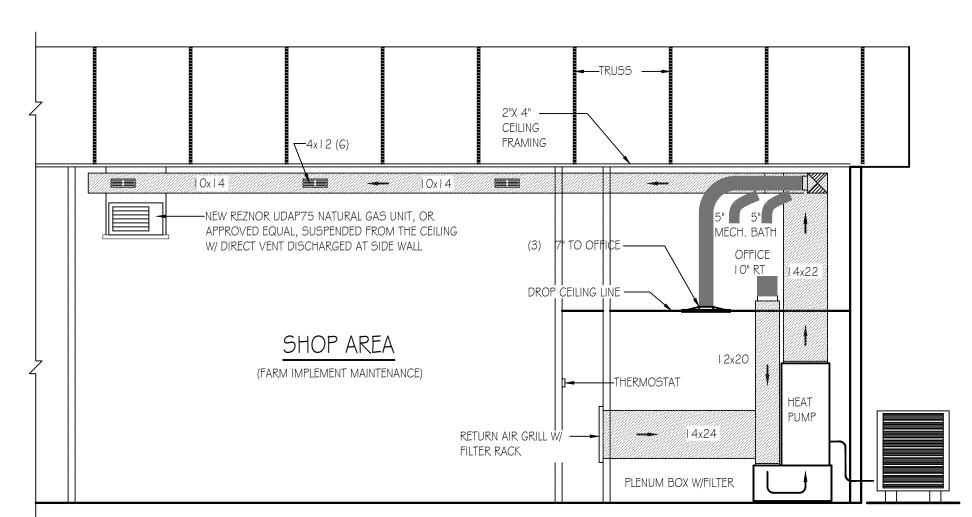

#### MECHANICAL CONSTRUCTION NOTES:

HVAC SYSTEM TO BE A BOSCH HEAT PUMP SYSTEM. LAYOUT OF DUCTS, DUCT SIZES AND DIFFUSERS ARE MEANT TO BE USED AS A GUIDELINE. ACTUAL RUNS, SIZES AND LOCATIONS TO BE DETERMINED BY MANUFACTURER'S MODEL.

THE FOLLOWING STEPS SHOULD BE FOLLOWED IN THE DESIGN AND INSTALLATION OF THE HVAC SYSTEM TO ENSURE EFFICIENCY AND COMFORT.

I . DETERMINE ROOM-BY-ROOM AND AIR-FLOWS USING ACCA MANUAL J CALCULATION PROCEDURES. (OR SUBSTANTIALLY EQUIVALENT)

SIZE DUCT SYSTEM ACCORDING TO ACCA MANUAL D CALCULATION PROCEDURES. (OR SUBSTANTIALLY EQUIVALENT)
 SIZE HVAC EQUIPMENT TO SENSIBLE LOAD USING ACCA MANUAL S CALCULATION PROCEDURES (OR SUBSTANTIALLY EQUIVALENT).

4. INSTALL EQUIPMENT ¢ DUCTS ACCORDING TO DESIGN SPECIFICATIONS USING INSTALLATION PROCEDURES FROM SMACNA / MANUFACTURERS' SPECS.


5. INSTALL SO STATIC AIR PRESSURE DROP ACROSS THE AIR HANDLER IS WITHIN MANUFACTURER AND DESIGN SPECIFICATIONS.
6. PROVIDE BALANCED AIR FLOWS BETWEEN SUPPLY AND RETURN SYSTEMS TO MAINTAIN NEUTRAL PRESSURE.

7. EQUIPMENT AND ASSOCIATED ITEMS MUST BE APPROVED BY PGC HARRISBURG ENGINEERING DIVISION BEFORE START OF INSTALLATION.

HEAT PUMP TO BE A 5 TON BOSCH BOVA - 060-HDN I - M I 8M OUTSIDE CONDENSER UNIT W/ BGH96M I 00C5B AIR HANDLER/FURNACE AND BMAC4860CNTF CASE COIL. UNITS TO ACHIEVE A MINIMUM I 7 SEER AND 9.5 HSPF (OR SUBSTANTIALLY EQUIVALENT). SEE SPECIFICATIONS.

BUILDING SECTION - MECHANICAL

SCALE: 1/4" = 1'-0"

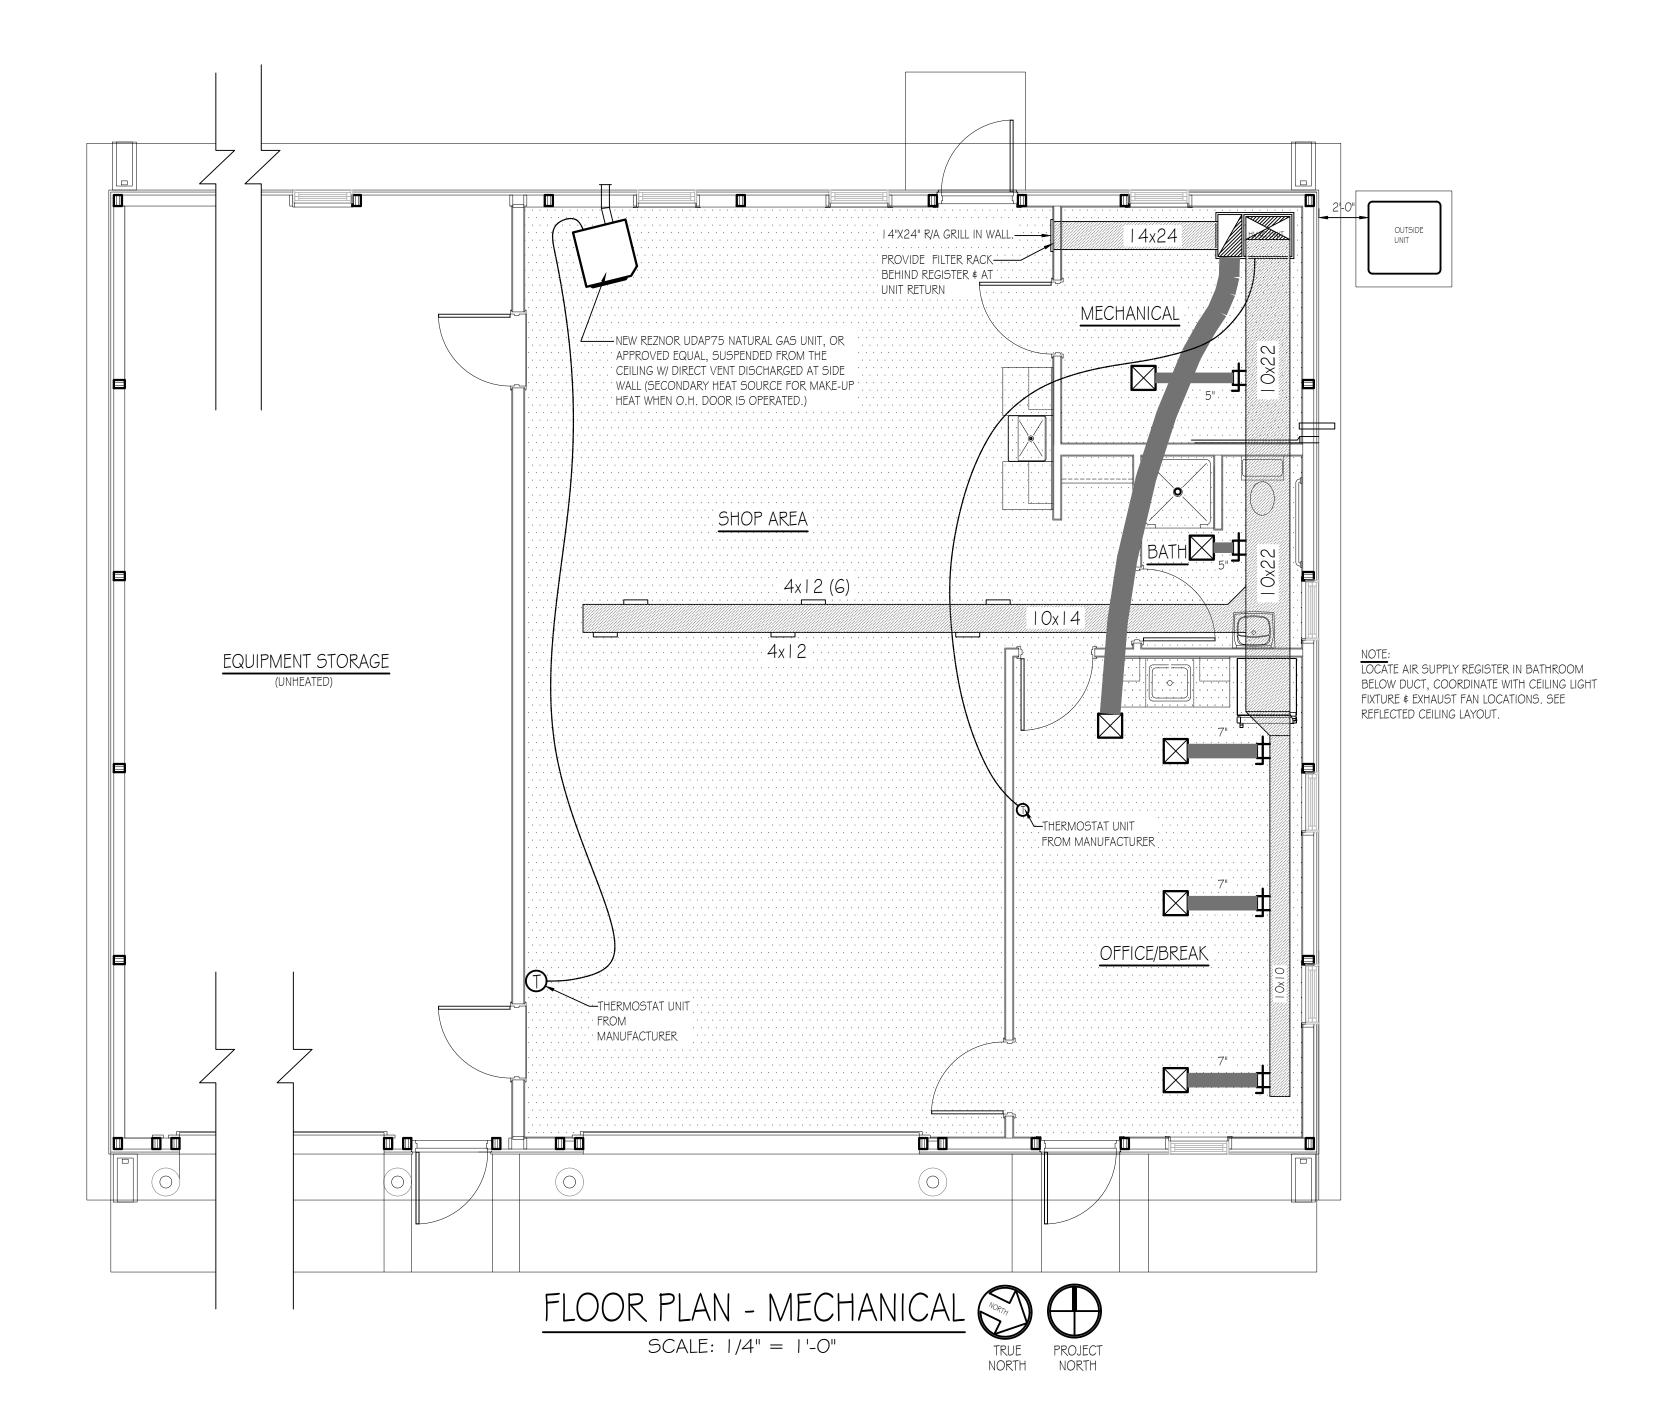



MECHANICAL FLOOR PLAN AND DETAILS
REVISIONS

PROJECT NO PC

PROJECT NO. PGC-289-22-01
DRAWN BY: M. SPOTTS
DATE: 11/22/2022
SHEET NO. M-1



PC  • 1,3  2,4  • 5,7  6,8  9,11  10,12  13,15  14,16  17  18  19  20  21  22  23	2 50 2 30 2 30 2 20 2 40 2 60 1 20 1 20 1 20 1 20	220 VOLT OUTLET (WELDER)  SPARE  220 VOLT OUTLET (WELDER)  220 VOLT OUTLET (AIR COMPRESSOR)  MECHANICAL ROOM DRYER RECEPTACLE  WELL PUMP  HVAC OUTSIDE UNIT  HVAC INSIDE AIR HANDER UNIT  WATER CONDITIONING EQUIPMENT  WATER HEATER  GAS HEATER  SERVICE PANEL RECEPTACLE	No./Size  3 - #6  3 - #6  3 - #10  3 - #10  3 - #10  3 - #8  Verify w/ M.C.  3 - #12  3 - #12  3 - #12  3 - #12	Size  -1/4"  -1/4"  -1/4"  -1/4"
2,4  *5,7  6,8  9,11  10,12  13,15  14,16  17  18  19  20  21  22	2 50 2 30 2 30 2 20 2 40 2 60 1 20 1 20 1 20	SPARE  220 VOLT OUTLET (WELDER)  220 VOLT OUTLET (AIR COMPRESSOR)  MECHANICAL ROOM DRYER RECEPTACLE  WELL PUMP  HVAC OUTSIDE UNIT  HVAC INSIDE AIR HANDER UNIT  WATER CONDITIONING EQUIPMENT  WATER HEATER  GAS HEATER  SERVICE PANEL RECEPTACLE	3 - #6 3 - #10 3 - #10 3 - #10 3 - #8 Verify w/ M.C. 3 - #12 3 - #12	- /4"   3/4"   3/4"   3/4"   Verify   3/4"   3/4"
+5,7 6,8 9,11 10,12 13,15 14,16 17 18 19 20 21 22	2 30 2 30 2 20 2 40 2 60 1 20 1 20 1 20	220 VOLT OUTLET (WELDER)  220 VOLT OUTLET (AIR COMPRESSOR)  MECHANICAL ROOM DRYER RECEPTACLE  WELL PUMP  HVAC OUTSIDE UNIT  HVAC INSIDE AIR HANDER UNIT  WATER CONDITIONING EQUIPMENT  WATER HEATER  GAS HEATER  SERVICE PANEL RECEPTACLE	3 - #10 3 - #10 3 - #10 3 - #8 Verify w/ M.C. 3 - #12 3 - #12	3/4" 3/4" 1" Verify 3/4" 3/4" 3/4"
6,8 9,11 10,12 13,15 14,16 17 18 19 20 21 22	2 30 2 30 2 20 2 40 2 60 1 20 1 20 1 20	220 VOLT OUTLET (AIR COMPRESSOR)  MECHANICAL ROOM DRYER RECEPTACLE  WELL PUMP  HVAC OUTSIDE UNIT  HVAC INSIDE AIR HANDER UNIT  WATER CONDITIONING EQUIPMENT  WATER HEATER  GAS HEATER  SERVICE PANEL RECEPTACLE	3 - #10 3 - #10 3 - #10 3 - #8 Verify w/ M.C. 3 - #12 3 - #12	3/4" 3/4" 1" Verify 3/4" 3/4" 3/4"
9,11 10,12 13,15 14,16 17 18 19 20 21	2 30 2 20 2 40 2 60 1 20 1 20 1 20	MECHANICAL ROOM DRYER RECEPTACLE  WELL PUMP  HVAC OUTSIDE UNIT  HVAC INSIDE AIR HANDER UNIT  WATER CONDITIONING EQUIPMENT  WATER HEATER  GAS HEATER  SERVICE PANEL RECEPTACLE	3 - #10 3 - #10 3 - #8 Verify w/ M.C. 3 - #12 3 - #12	3/4" 3/4"  Verify 3/4" 3/4" 3/4"
10,12 13,15 14,16 17 18 19 20 21	2 20 2 40 2 60 1 20 1 20 1 20 1 20	WELL PUMP HVAC OUTSIDE UNIT HVAC INSIDE AIR HANDER UNIT WATER CONDITIONING EQUIPMENT WATER HEATER GAS HEATER SERVICE PANEL RECEPTACLE	3 - #10 3 - #8 Verify w/ M.C. 3 - #12 3 - #12	3/4"   "   Verify   3/4"   3/4"
13,15 14,16 17 18 19 20 21 22	2 40 2 60 1 20 1 20 1 20 1 20	HVAC OUTSIDE UNIT  HVAC INSIDE AIR HANDER UNIT  WATER CONDITIONING EQUIPMENT  WATER HEATER  GAS HEATER  SERVICE PANEL RECEPTACLE	3 - #8  Verify w/ M.C.  3 - #12  3 - #12  3 - #12	Verify 3/4" 3/4"
14,16 17 18 19 20 21 22	2 60 1 20 1 20 1 20 1 20	HVAC INSIDE AIR HANDER UNIT  WATER CONDITIONING EQUIPMENT  WATER HEATER  GAS HEATER  SERVICE PANEL RECEPTACLE	Verify w/ M.C.  3 - #12  3 - #12  3 - #12	Verify 3/4" 3/4" 3/4"
17 18 19 20 21 22	20   20   20   20	WATER CONDITIONING EQUIPMENT WATER HEATER GAS HEATER SERVICE PANEL RECEPTACLE	3 - #12 3 - #12 3 - #12	3/4" 3/4" 3/4"
18 19 20 21 22	20   20   20	WATER HEATER  GAS HEATER  SERVICE PANEL RECEPTACLE	3 - #12	3/4" 3/4"
19 20 21 22	l 20	GAS HEATER SERVICE PANEL RECEPTACLE	3 - #12	3/4"
20 21 22	1 20	SERVICE PANEL RECEPTACLE		
21			3 - #12	1
22	1 20	SHOP RECEPTACIES WIGEIC PROTECTION		3/4"
		SHOT RECEITABLES WOLLD FROTEGUE	3 - #12	3/4"
22	1 20	SHOP RECEPTACLES W/GFIC PROTECTION	3 - #12	3/4"
23	1 20	WORK SHOP GENERAL LIGHTING	3 - #12	3/4"
24		SPARE		
25	1 20	UTILITY GFI RECEPTACLES	3 - #12	3/4"
26	1 20	OFFICE, RESTROOM, \$ MECH. LIGHTING	3 - #12	3/4"
27	1 20	EQUIPMENT STORAGE LIGHTING	3 - #12	3/4"
28	1 20	EQUIPMENT STORAGE RECEPTACLES W/GFIC PROTECTION	3 - #12	3/4"
29	1 20	EQUIPMENT STORAGE RECEPTACLES W/GFIC PROTECTION	3 - #12	3/4"
30	1 20	REFRIGERATOR	3 - #12	3/4"
31	1 20	OFFICE RECEPTACLES	3 - #12	3/4"
32	1 20	BREAK, RESTROOM GFI RECEPTACLES	3 - #12	3/4"
33	1 20	MICROWAVE	3 - #12	3/4"
34	1 20	CLOTHES WASHER RECEPTACLE	3 - #12	3/4"
35	1 20	GARAGE DOOR OPENER RECEPTACLES	3 - #12	3/4"
36 - 42		SPARE SPACES		

PANEL SCHEDULE NOTES

\* Match receptacle to welder

	LIGHTING FIXTURE SCHEDULE						
MARK	QTY	FIXTURE TYPE	MODEL				
Α	3	2' X 4' LED PANEL	SIMKAR LDP2450L40U I				
В		15.25" X 22" 4 LAMP LED HIGH BAY	LITHONIA IBH 15000LM SD080 MD OZ10 40K, 80 CRI				
С		2' INTEGRATED LED WALL MOUNT VANITY LIGHT (18 WATT)	LITHONIA FMVTSL 3000K				
D	3	SECURITY MOTION, WALL MOUNT/OUTSIDE UNIT	HEATH ZENITH SL-5630-BZ				
E	3	EXIT & EMERGENCY COMBO LIGHT W/BATTERIES & REMOTE HEAD	LITHONIA ECRLEDHO MG W/ELA LED WP M I 2				
F		2' X 2' LED PANEL	SIMKAR LDP2240L40U I				
G		I I O CFM, CEILING MOUNT EXHAUST FAN	BROAN AER I I OK				

RECEPTACLE & SWITCH MOUNTING HEIGHTS MICROWAVE WASHER DRYER OFFICE RECEPTACLES AND TELEPHONE ALL SWITCHES AND OTHER RECEPTACLES

#### ELECTRICAL WIRING SYMBOLS

### **WR-GFI GFI-WATER RESISTANT-RECEPTACLE**

- GFI
  GFI RECEPTACLE
- DUPLEX OUTLET, SPLIT CIRCUIT DUPLEX OUTLET
- 50 AMP, 220 VOLT OUTLET, WELDER (VERIPY TYPE \$ LOCATION WITH PGC)
- 30 AMP, 220 VOLT OUTLET 30 AMP, 220 VOLT OUTLET (DRYER)
- → HOME RUN/CIRCUIT # ➤ TELECOMMUNICATIONS OUTLET
- JUNCTION BOX
- PHOTO CELL ▶□ EXIT LIGHTING W/BATTERIES
- \$ SWITCH
- \$3 SWITCH, 3 WAY \$4 SWITCH, 4 WAY
- SOC SWITCH, OCCUPANCY SENSOR
- PS PRESSURE SWITCH WATER PUMP

#### GENERAL ELECTRICAL NOTES:

- FURNISH AND INSTALL SOLID COPPER CONDUCTORS AS SPECIFIED; NO ALUMINUM AND NO STRANDED. MC CABLE IS APPROVED FOR ALL HOME RUN CIRCUITS IF NEATLY INSTALLED.
- 2 ALL CONDUCTORS FOR 120V CIRCUITS OVER 100' IN LENGTH SHALL BE MINIMUM #10AWG. ALL CONDUCTORS FOR 120V CIRCUITS OVER I 50' IN LENGTH SHALL BE MINIMUM #8AWG. CONTRACTOR IS RESPONSIBLE FOR VERIFICATION OF FINAL CIRCUIT LENGTHS AND CORRESPONDING WIRE SIZE TO ENSURE VOLTAGE DROP IS MAINTAINED WITHIN NEC LIMITS.
- 3. ALL WORK SHALL BE PERFORMED AS REQUIRED BY APPLICABLE SECTION OF THE NATIONAL ELECTRICAL CODE (NEC), LATEST EDITION, AND ALL GOVERNING UCC BUILDING CODES AND REGULATIONS.
- 4. PROVIDE GROUNDING AND BONDING FOR ELECTRICAL SYSTEMS. ELECTRICAL COMPONENTS, DEVICES AND ACCESSORIES SHALL BE LISTED AND LABELED AS DEFINED IN NFPA 70 AND COMPLY WITH UL 467 FOR GROUNDING AND BONDING MATERIALS AND EQUIPMENT. INSTALL INSULATED EQUIPMENT GROUNDING CONDUCTORS ALL FEEDERS AND BRACH CIRCUITS, LIGHTING CIRCUITS, RECEPTACLE CIRCUITS SINGLE PHASE MOTOR AND APPLIANCE BRANCH CIRCUITS, ARMORED AND METAL-CLAD CABLE RUNS AND AS REQUIRED BY NFPA 70.
- 5. PROVIDE ALL HANGERS AND SUPPORTS FOR ELECTRICAL SYSTEMS, INCLUDING STEEL SLOTTED SUPPORT SYSTEMS, CONDUIT AND CABLE SUPPORT DEVICES, SUPPORTS FOR CONDUCTORS IN VERTICAL CONDUIT. HANGERS AND SUPPORTS SHALL HAVE A FLAME RATING OF CLASS I AND BE SELF-EXTINGUISHING ACCORDING TO ASTM D 635.
- PROVIDE CATG WIRE LABELED AND RAN FROM EACH DATA BOX TO MECHANICAL ROOM, PROVIDE 10' ADDITIONAL COILED LENGTH IN
- 7. MOUNT COMBINATION EXIT/EMERGENCY LIGHTING UNITS TO THE LIGHTING BRANCH CIRCUIT IN THE ROOM IT IS SERVING ON THE LINE SIDE OF

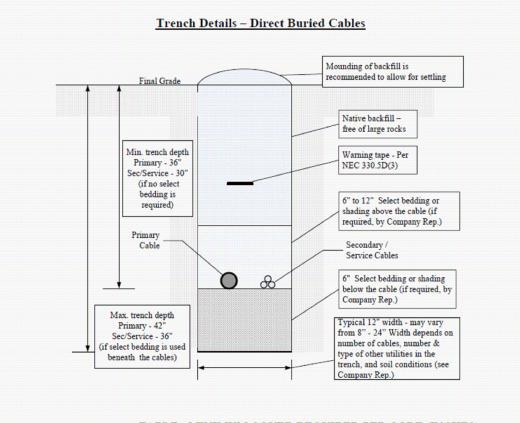


TABLE - MINIMUM COVER REQUIRED PER CODE (INCHES)


FirstEnergy.

Owner / Code	Customer Installed Facilities / NEC <sup>(1)</sup>					
Voltage (Ó- Ó)	Direct Buried	Rigid Metallic Conduit (RMC)	•	Street / Road Parking Lot <sup>(2)</sup>	Direct Bur	
0 – 600 V	24	6	18	24	24	
> 600 V- 22 kV	30	6	18	24	30	
> 22 kV - 40 kV	36	6	24	24	30	

Notes: (1) FEOC typically requires an additional 6 inches of cover to allow for variation in final grade. (2) For cables located beneath roads under Penn DOT jurisdiction, cables must be installed in conduit and

have a minimum of 36 inches of cover.

TRENCH DETAILS FOR DIRECT Service Guide

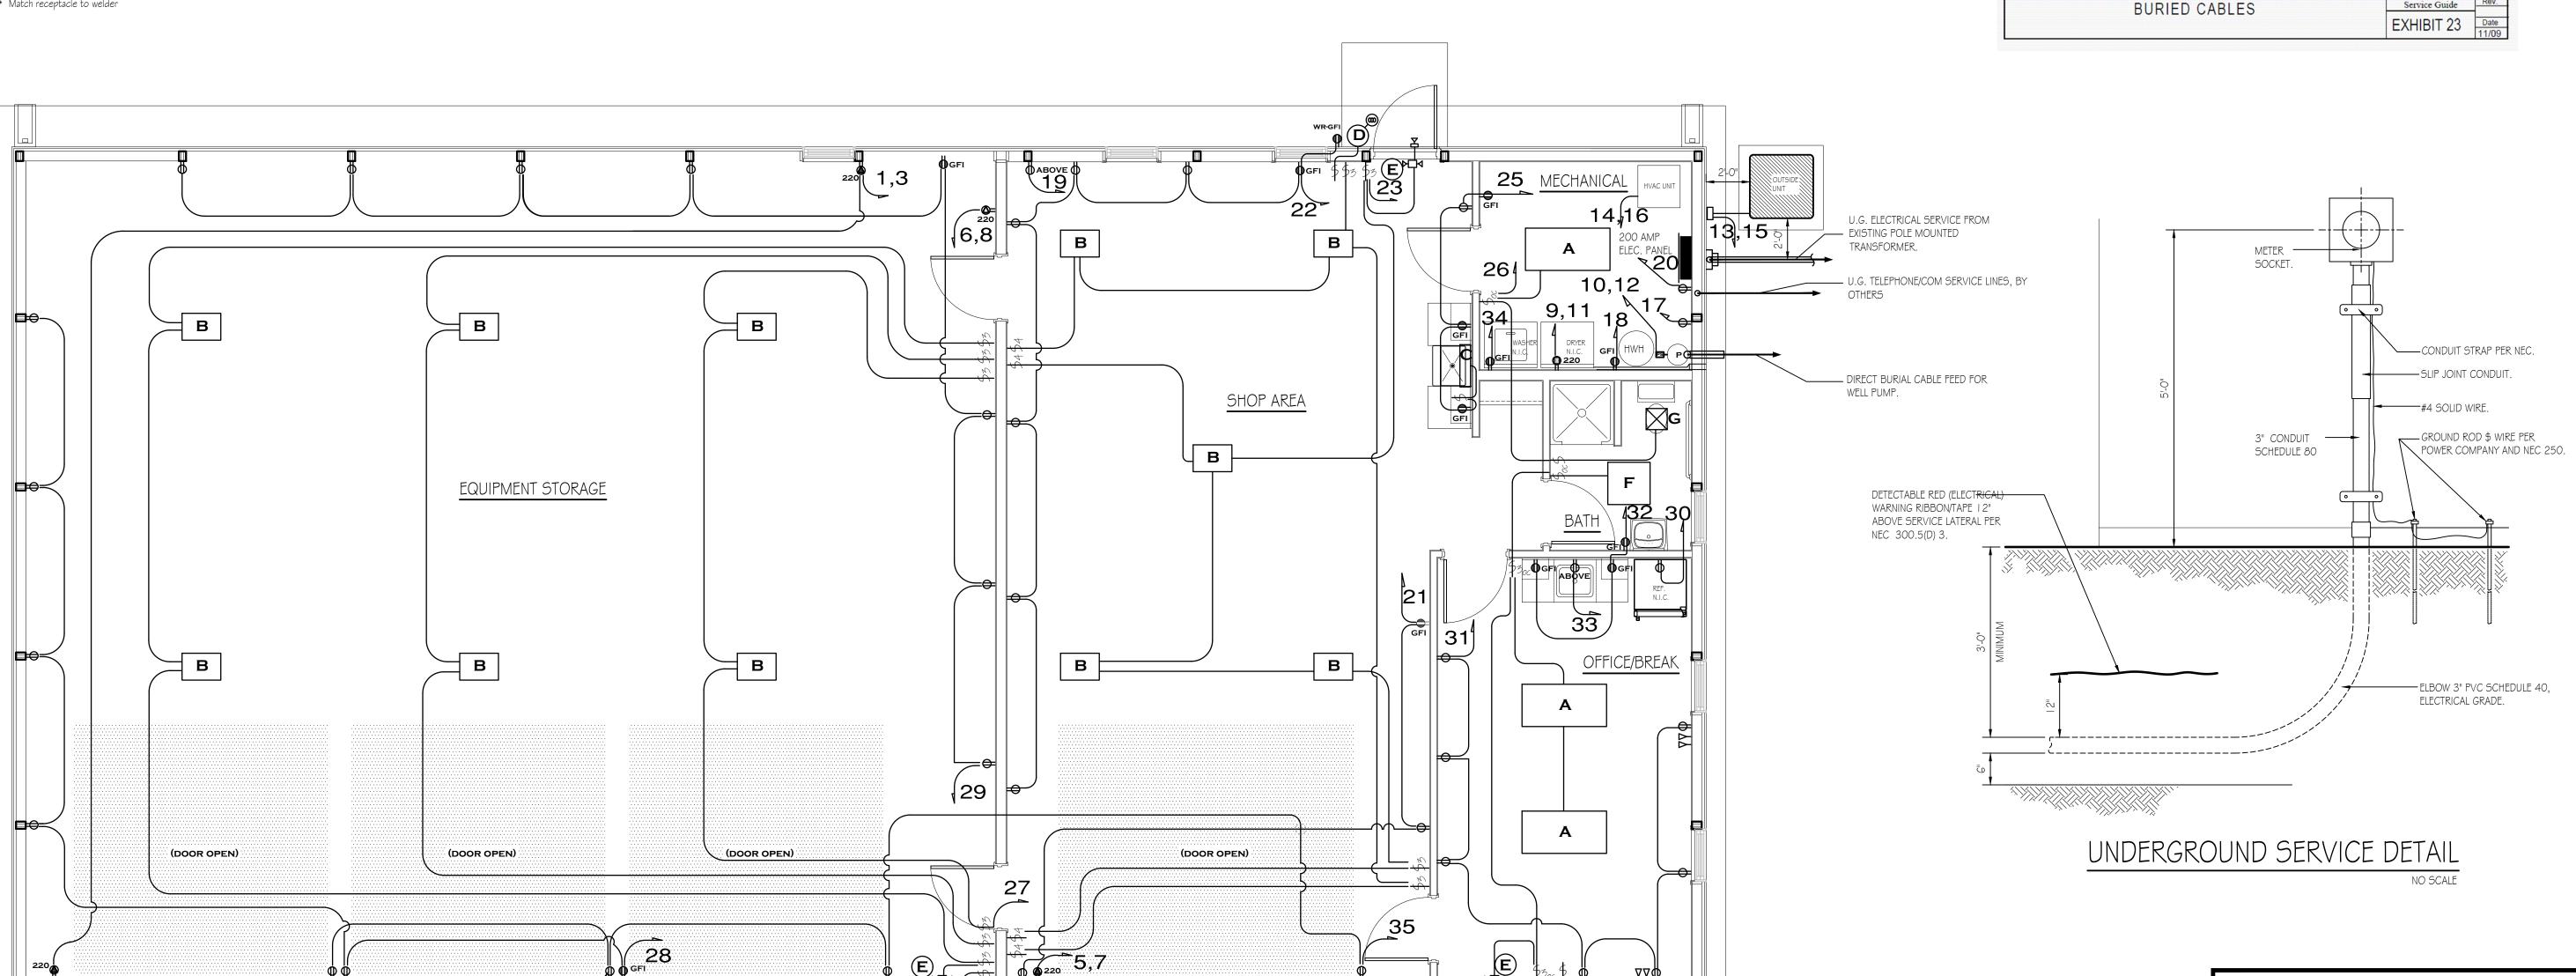


NEW CREW BUILDING - ELECTRICAL PLAN SCALE: 1/4" = 1'-0"

OVERHEAD DOOR LIFT RECEP<del>TACLES</del>

TO BE MOUNTED AT DOOR HEADER

HEIGHT,

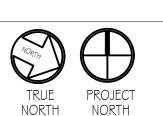

PENNSYLVANIA GAME COMMISSION ELECTRICAL FLOOR PLAN, SCHEDULES & DETAILS

REVISIONS PGC-289-22-01 M. SPOTTS DRAWN BY:

SHEET NO.

11/22/2022